

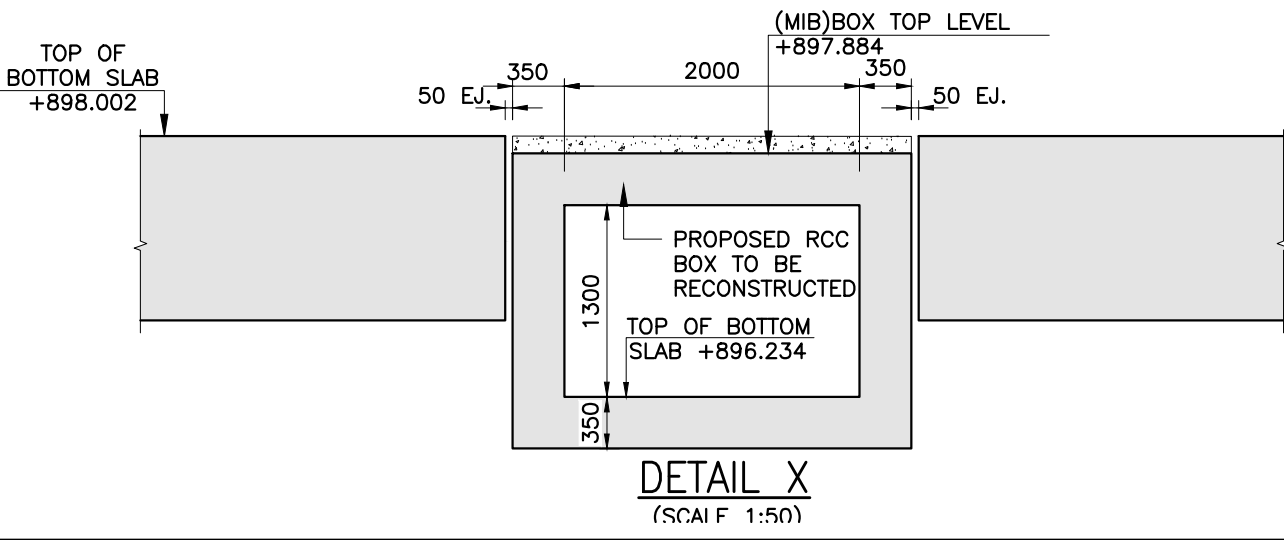
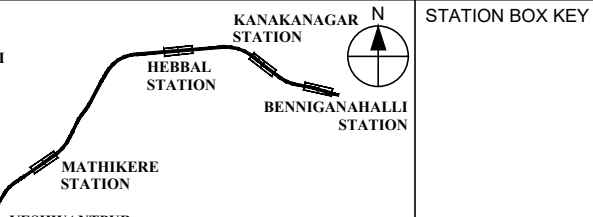
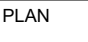


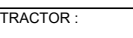


CROSS BEAM DIMENTION	
BEAM	SIZE
SB1	400 x 800
EB1	400 x 800
LB1	400 x 800

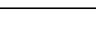

NOTES:				LEGEND:		REFERENCE DRAWINGS :				REFERENCE DOCUMENTS:				KEY PLAN				STATION BOX KEY PLAN			
1. ALL DIMENSIONS ARE IN MILLIMETERS UNLESS SPECIFIED OTHERWISE. 2. FOLLOW FIGURED DIMENSIONS ONLY. 3. THIS DRAWING SHOULD BE READ IN CONJUNCTION WITH GENERAL ARRANGEMENT AND RAIL ALIGNMENT DRAWINGS. 4. MEP, PEB & STATION ROOF WORKS ARE NOT IN OUR SCOPE. 5. ARCHITECTURE DETAILS ARE NOT IN SCOPE. 6. FOR OTHER NOTE PLEASE REFER DRG. NO. 02077-BSRP-CR2-C-UB-0-10-1307 (SH-1,2,3 & 4) 7. REFER ARCHITECTURAL DRAWING FOR DETAILS OF OPENINGS.						1. 02077-BSRP-CR2-C-UB-0-10-1306 (SH-1, 2 OF 2) : GENERAL ARRANGEMENT DRAWING OF KANAKANAGAR STATION 2. 02077-BSRP-CR2-C-UB-0-10-1307 (SH-1 TO 4) : DIMENSION DETAIL OF KANAKANAGAR STATION (AT GRADE)				DOC-BSRP-CR2-AG-DGN-BR-10-1587 : DESIGN OF STATION BOX AT CHB+582 OF KANAKANAGAR STATION											
REVISIONS				CONTRACTOR:		QUALITY ASSURANCE				GENERAL CONSULTANTS				EMPLOYER :				PROJECT :			
						The responsibility of control, check and verification of accuracy, correctness, completeness, integration and full compliance of Contract provisions in respect of design analysis and drawing rests with Design & Build Contractor.								 RAIL INFRASTRUCTURE DEVELOPMENT COMPANY (KARNATAKA) LIMITED				BENGALURU SUBURBAN RAILWAY PROJECT (BSRP) K-RIDE CORRIDOR - 2			
DETAILED DESIGN CONSULTANT (DDC):				PROOF CONSULTANT (PC):														DRAWING TITLE :			
																		DIMENSION DETAIL DRAWING OF KANAKANAGAR STATION			
C 18.11.24 FOR APPROVAL				Indian Institute of Technology Madras IIT P.O., Chennai 600 036 INDIA														DRAWING NO. :			
B 19.07.24 FOR APPROVAL																		02077-BSRP-CR2-C-UB-0-10-1307 (SH-2 OF 4)			
A 19.06.24 FOR APPROVAL																		REVISION DWG STATUS			
REV DATE BRIEF DESCRIPTION																		C D			
																		SCALE : AS SHOWN DATE : 18.11.2024			
																		PRELIMINARY DWG (P), DEFINITIVE DWG (D), CONSTRUCTION DWG (C), AS BUILT DWG (B), SHOP DWG (S), MANUFACTURED DWG (M), SHEET SIZE - A1			